



Architectural & Engineering DESIGN

l de la companya del la companya de la companya del la companya de		5	4	CATCH BASIN & STORM DRAIN PIPING SCHEDULE INLET OPENING OUTLET PIPING OUTLET OPENING OUTLET PIPING	Archite Engin DES Associa 1246 P.O. E Plattsburgh, N tel: 518.
	PROPOSED 12" DIA. ROOF DRAIN COLLECTOR PIPING FROM CB1 TO DMH1 TO INCLUDE 6"	TYP. 2' GRASS SHOULDER AT EDGE OF PAVEMENT W/ 4% CROSS SLOPE, UNLESS		BE SMOOTH WALL INTERIOR SOIL TIGHT HDPE, ADS N-12 S1, OR EQUAL ALL STORM DRAIN PIPING TO DAYLIGHT SHALL TERMINATE WITH A FLARED END SECTION (AS INDICATED BY F.E.S.) STORM DRAIN PIPING SIZED TO CONVEY THE 25-YEAR STORM EVENT RUNOFF PER FIGURE 3-1 DISCHARGE RATES FOR ADS CORRUGATED PIPE WITH SMOOTH INTERIOR LINER PER THE ADS, INC. DRAINAGE HANDBOOK	Tax: 518. fax: 518. email: aedapo UNAUTHORIZED ALT ADDITIONS TO THIS I LICENSED ARCHITEC SEAL IS A VIOLATION SUBDIVISION 2, OF TI EDUCATI ONLY COPIES FROM TI DRAWING BEARIN ARCHITECT'S OR EN SIGNATURE SHALL BE TRUE
	DIA. SCH. 40 PVC DOWNSPOUT RISERS AS COORDINATED W/ GUTTER ASSEMBLY 366 365 365	NOTED OTHERWISE —PROPOSED VE	TOP OF WALL ELEV. = 362.8± BOT. OF WALL ELEV. = 350.5± F.E.S. AT OUTLET OF PIPE THROUGH RETAINING WALL INV.=351.00 PROPOSED TIMBER LEVEL SPREADER SPILLWAY INV. = 349.00 TYP. RIPRAP OUTLET APRON PROTECTION PROPOSED VEGETATED SWALE #4,		VELOPMENT, LLC
	DOLLAR GENERAL BUILDING "A" 9,100 SF 70'-0" x 130'-0" FF = 366.42 TYP. 5% SLOPE AWAY FROM BUILDING FOR 10' IN GRASS AREAS 365.90 366.40 365.90 366.40 365.90	365.90 TC365.70 X364.90 TC365.70 X364.90 X364.20 X364.21 X364.21 X364.21 X364.21 X364.21 X364.21 X364.21	LENGTH = 99 LF, SLOPE = 0.7% START INV. = 362.33 INV. OUT = 361.64 BTM. WIDTH = 3' TOP OF WALL ELEV. = 363.5± BOT. OF WALL ELEV. = 359.0± PROPOSED INFILTRATION BASIN BOTTOM ELEV. = 346.00 TYP. 4H:1V SLO BERM & 3H:1V F	PE TO A 5' WIDE ETURN SLOPE TO GRADE	SEVILLE DE SERVIL
	INV. UU1 = 302.33 /	364. 364. 605.53 367. 70 367. 70 618. 367. 70	TYP. 4' GRASS SHOULDER AT EDGE OF PAVEMENT W/ 4% CROSS SLOPE, ALONG DOWNHILL SIDE OF ENTRY DRIVE	EXT'G CONCRETE HEAD WALL -EXT'G 24" METAL CULVERT INV = 343.2' 344 344	C NO Architec DESTO
	BTM. WIDTH = 2' PROPOSED VEGETATED SWALE #2, LENGTH=36 LF, SLOPE=9.3% START INV. =365.86 INV. OUT = 362.53 BTM. WIDTH = 2'		GRAPHIC SCALE 30 0 15 30 60 17	SITE GRADING PLAN SCALE: 1" = 30'	SITE GRA
			(IN FEET) 1 inch = 30 ft.	YOPPROX.	PROJECT NO DATE DRAWN BY CHECKED BY

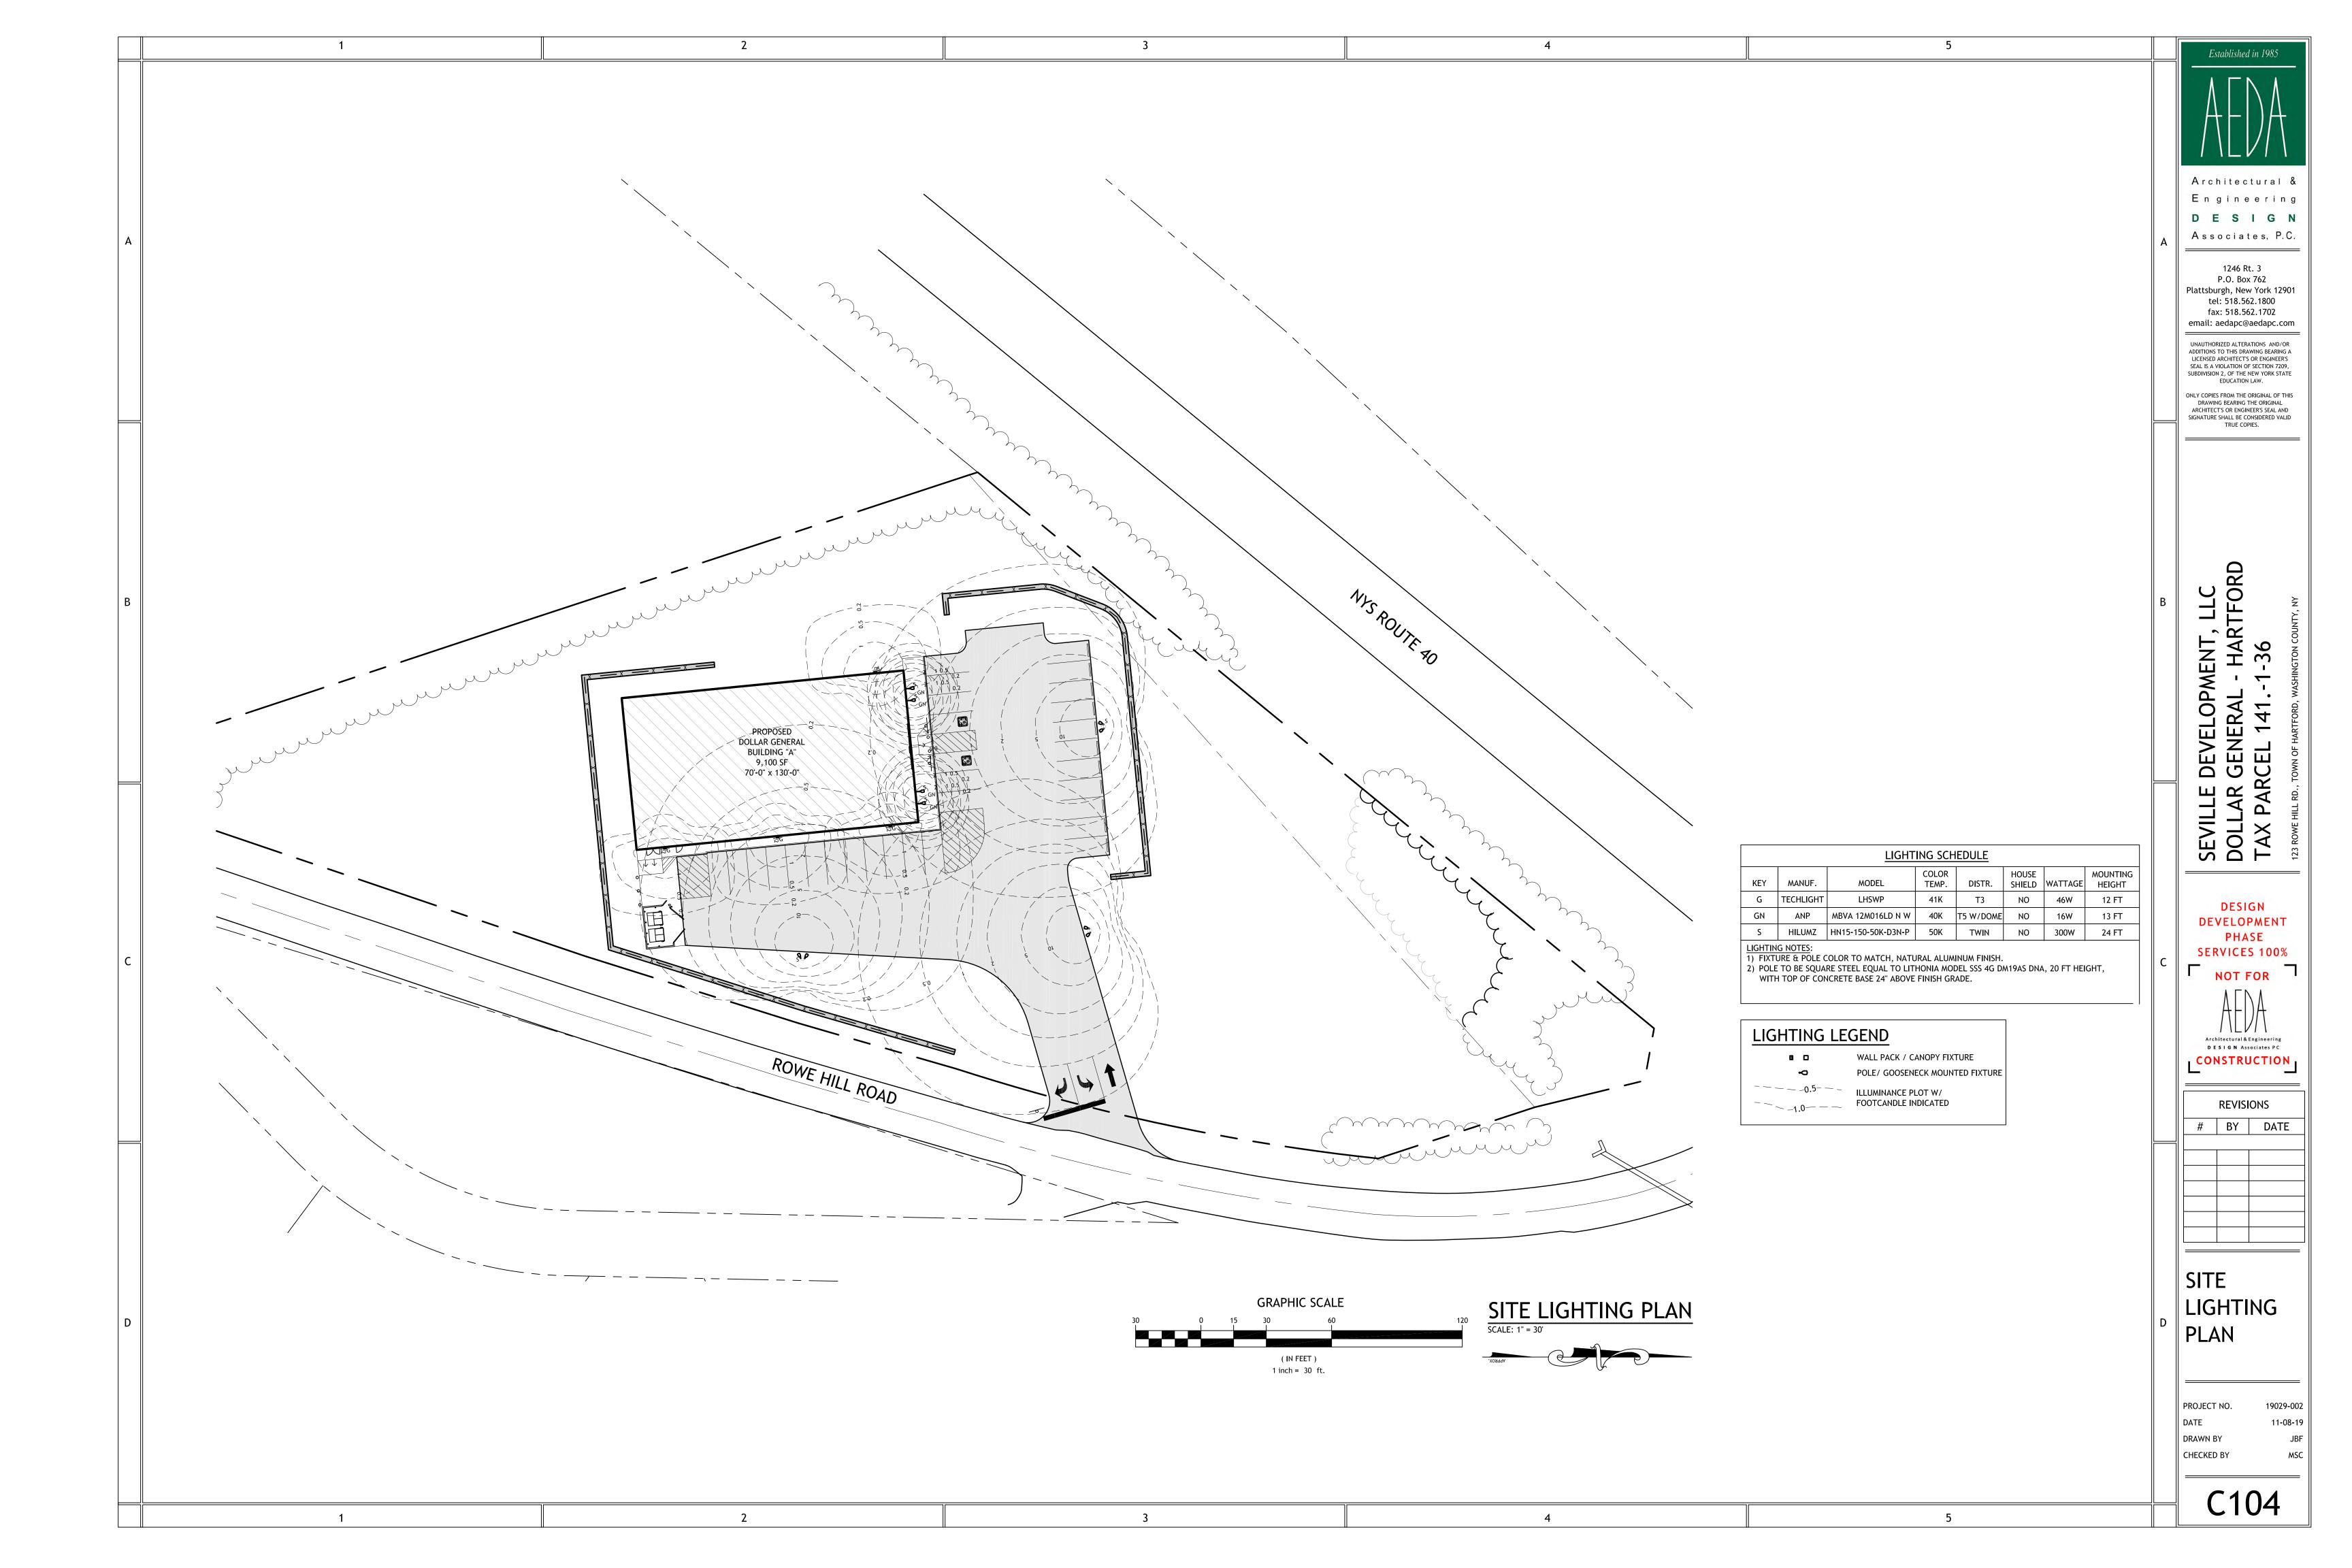

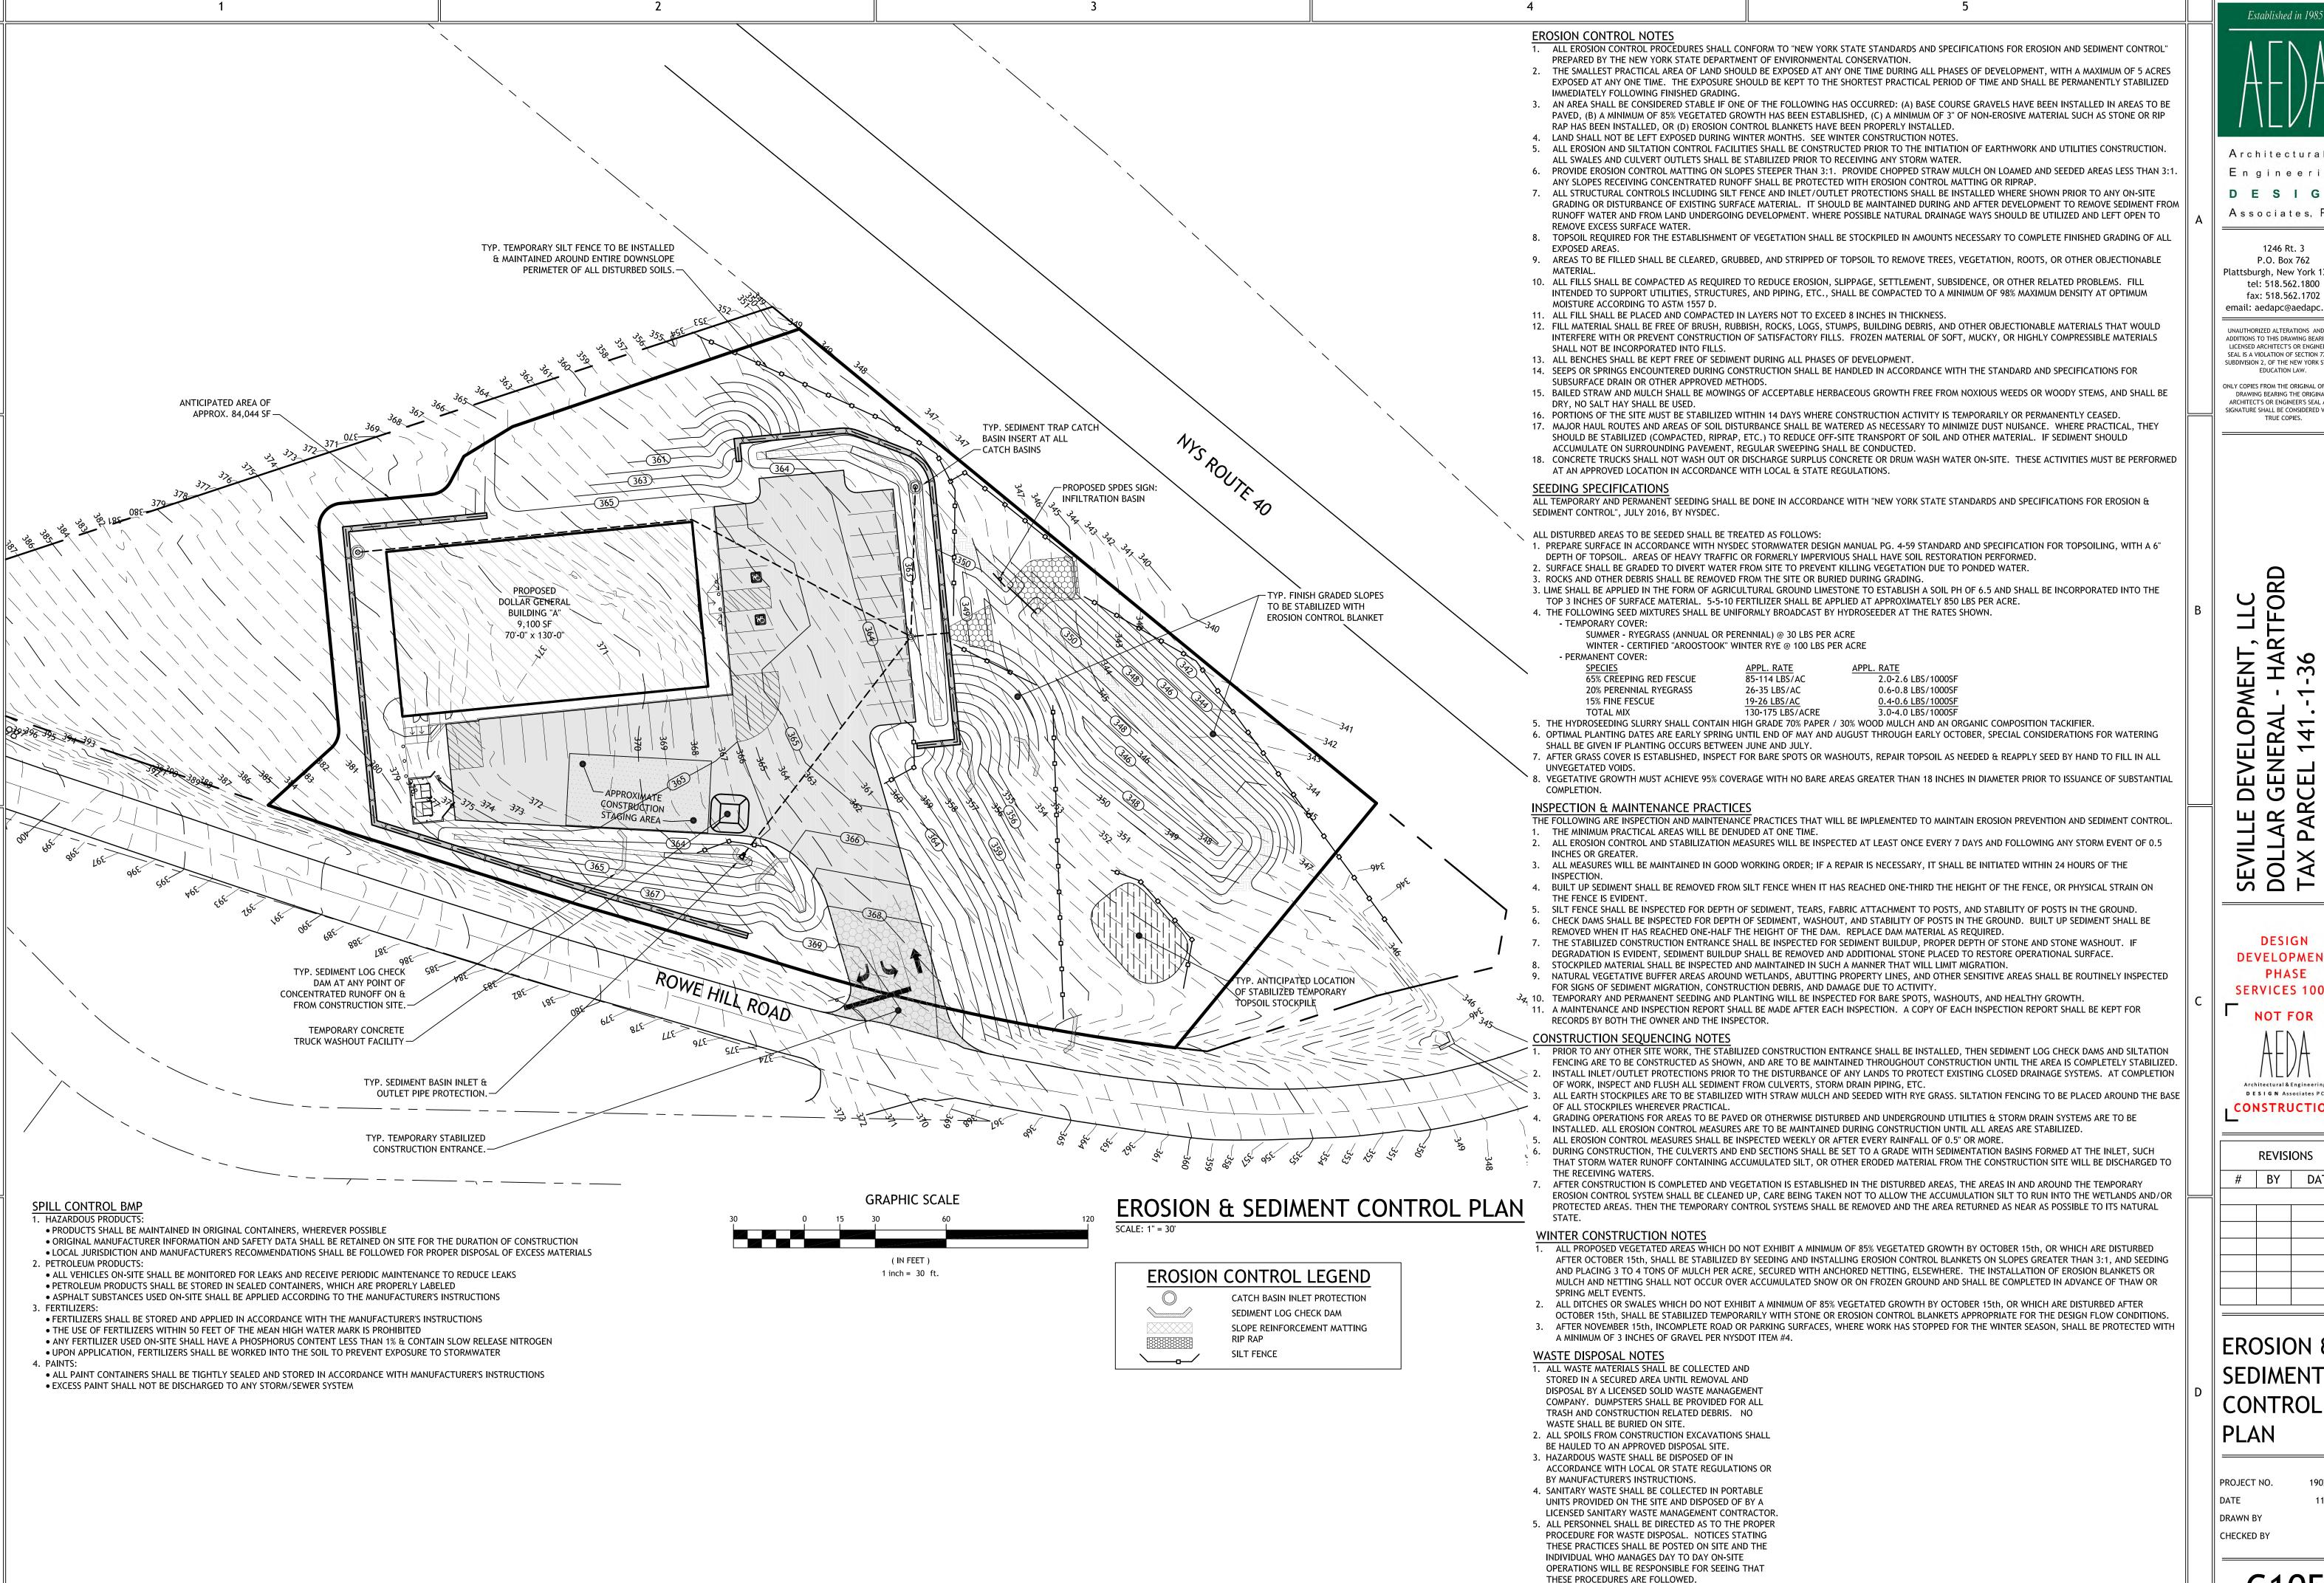

2

Architectural & Engineering DESIGN Associates, P.C.

1246 Rt. 3 P.O. Box 762 Plattsburgh, New York 12901

tel: 518.562.1800 fax: 518.562.1702 email: aedapc@aedapc.com

INAUTHORIZED ALTERATIONS AND/OR ADDITIONS TO THIS DRAWING BEARING A LICENSED ARCHITECT'S OR ENGINEER'S SEAL IS A VIOLATION OF SECTION 7209. SUBDIVISION 2, OF THE NEW YORK STATE EDUCATION LAW.

ONLY COPIES FROM THE ORIGINAL OF THIS DRAWING BEARING THE ORIGINAL

ARCHITECT'S OR ENGINEER'S SEAL AND SIGNATURE SHALL BE CONSIDERED VALID TRUE COPIES.

ш

DESIGN **DEVELOPMENT**

PHASE **SERVICES 100%**

Architectural & Engineering D E S I G N Associates PC


CONSTRUCTION


REVISIONS

BY DATE

EROSION & SEDIMENT CONTROL

PROJECT NO. 19029-002 11-08-19 DRAWN BY CHECKED BY

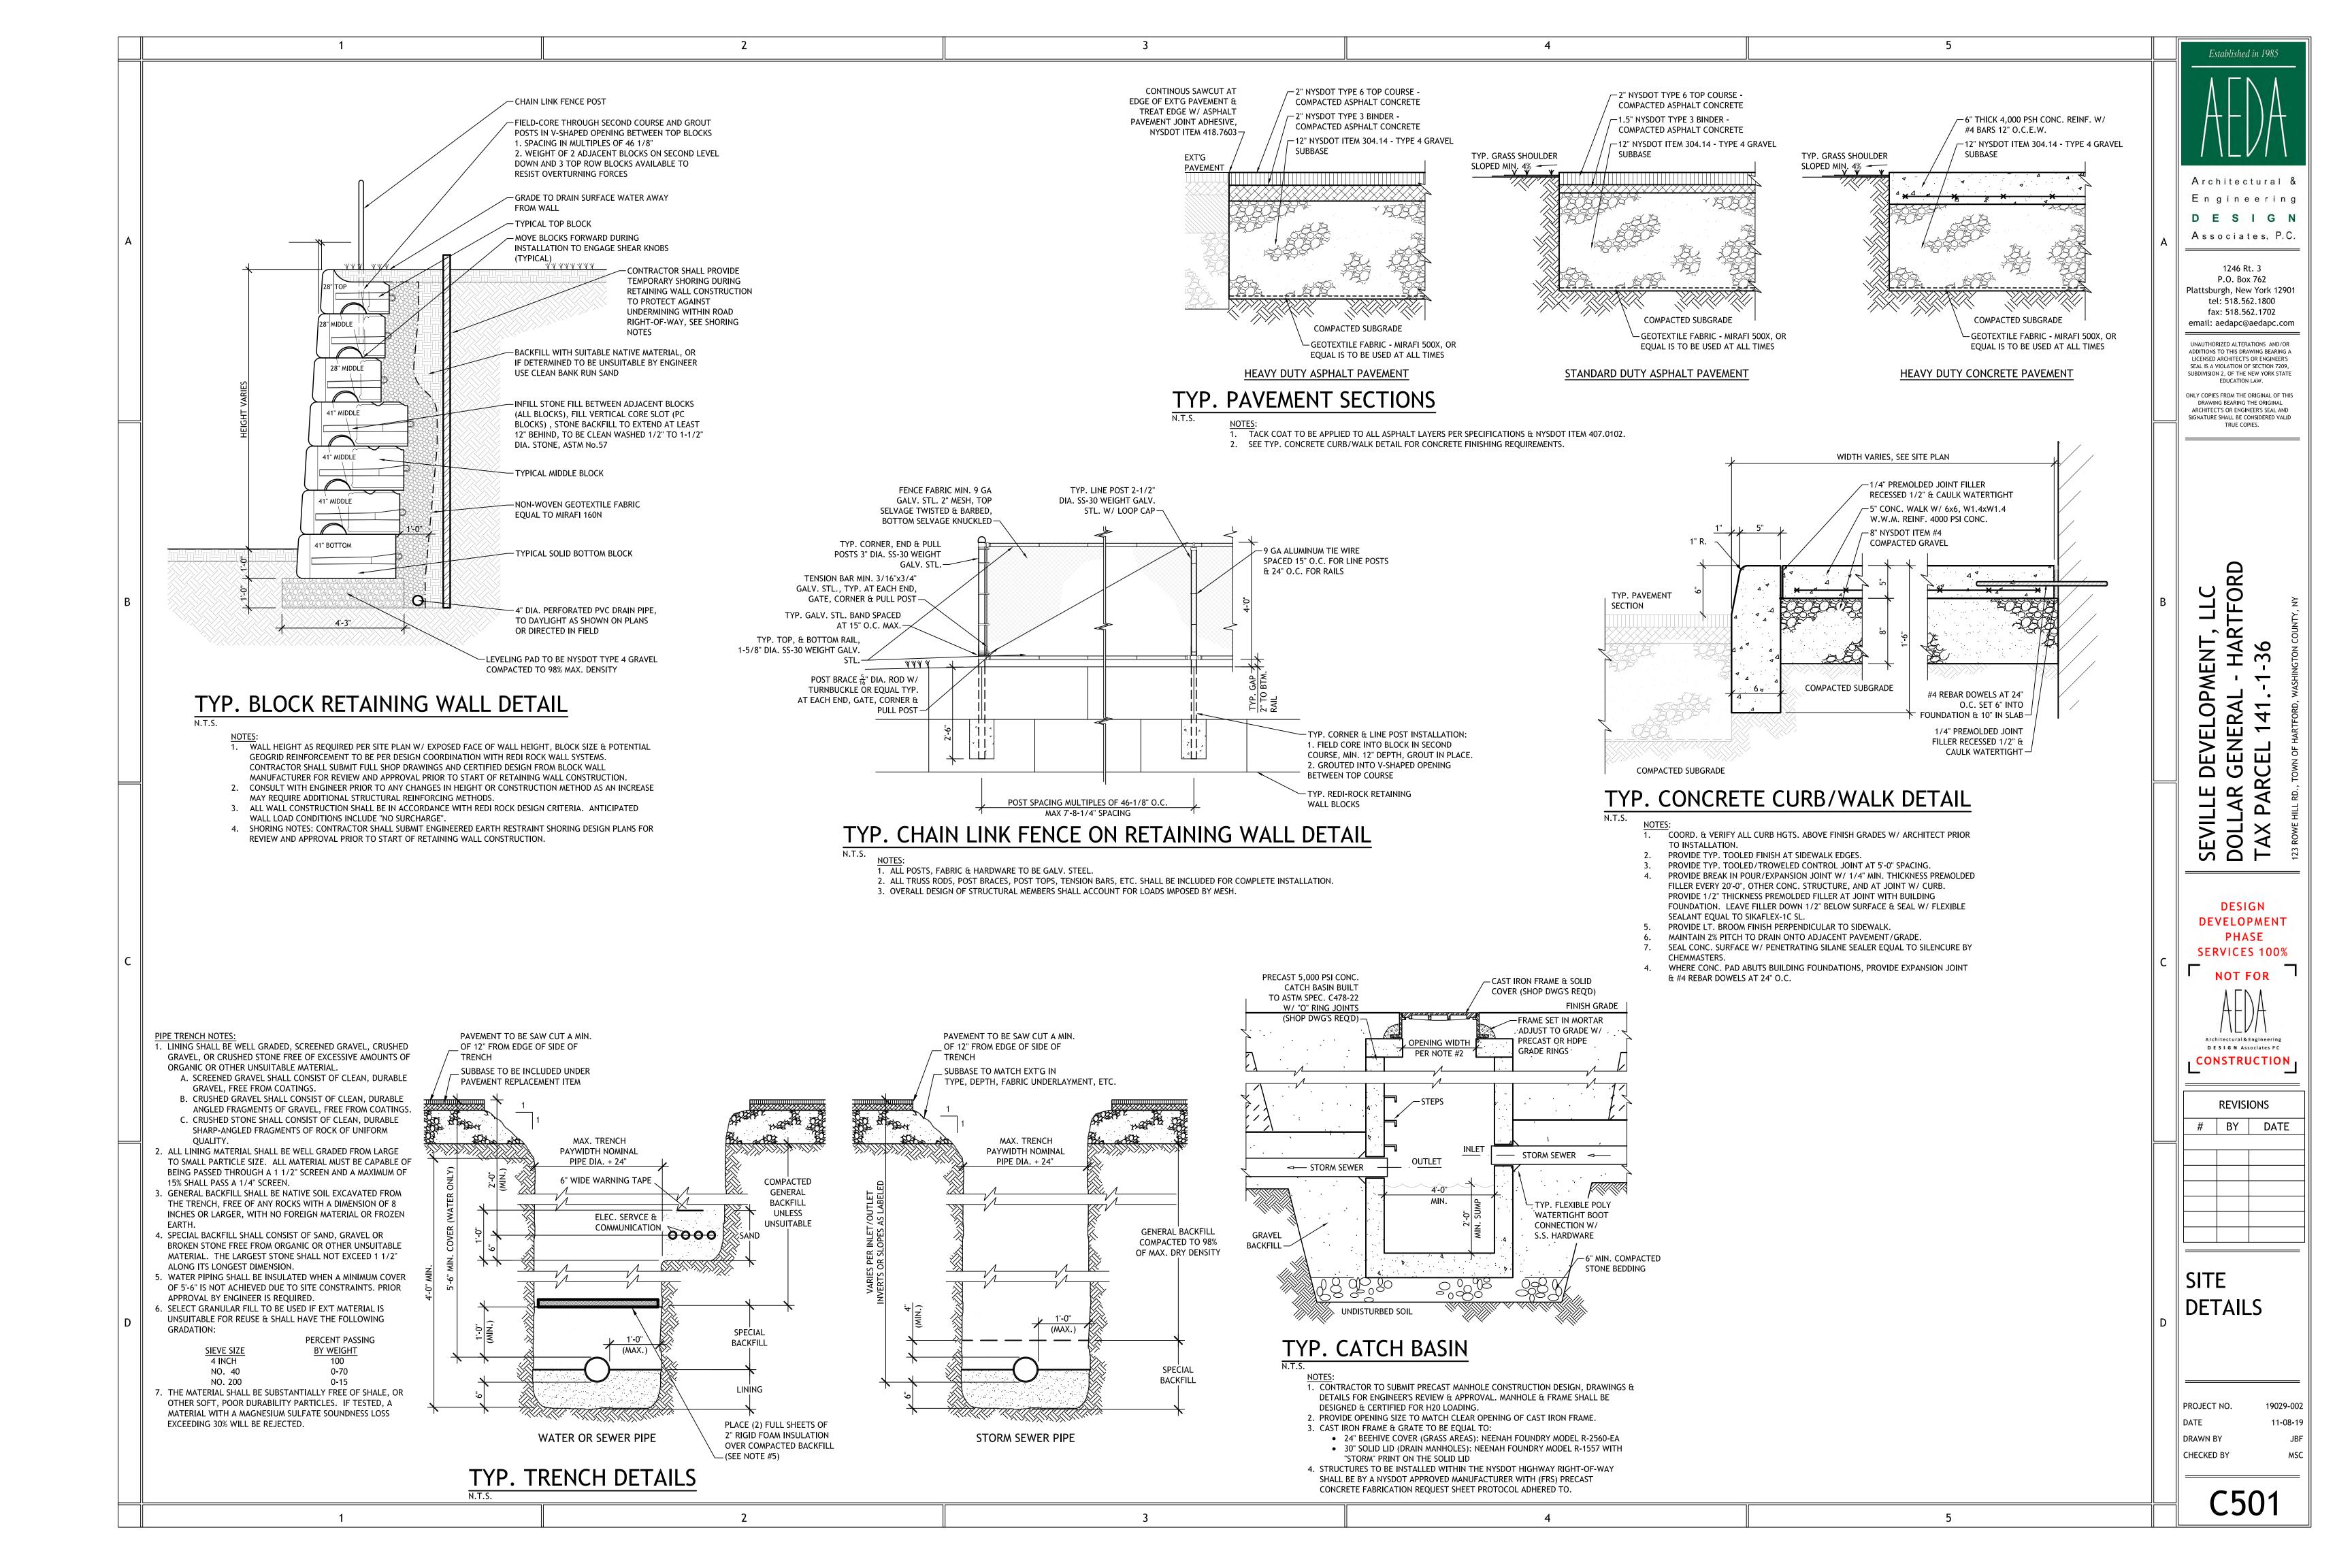

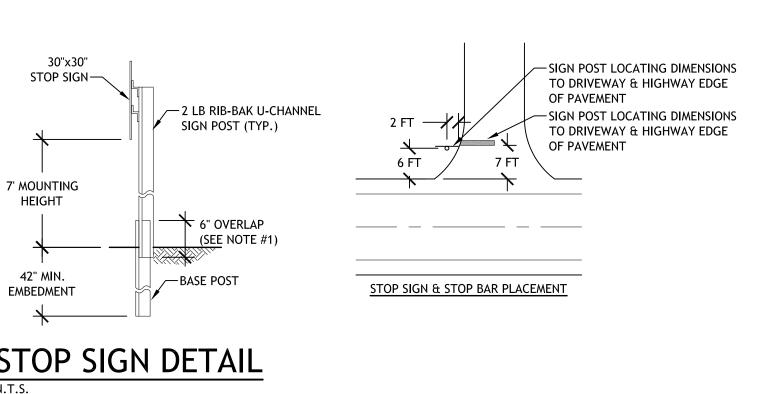

STOP SIGN DETAIL

- 1) BASE POST TO BE MAX. 4" ABOVE GRADE, TWO 3/8" DIA. HEX HEAD BOLTS W/ NUTS & WASHERS TO CONNECT BASE POST & TOP POST SPACED 4" APART.
- 2) STOP SIGN TO BE NYSDOT TYPE R1-1C. 3) SIGN POST TO BE "BREAK-AWAY", PER NYSDOT STANDARD HWP.

TYP. PIPE BOLLARD DETAIL

SEE TYP. PARKING SIGN DETAIL FOR SIGN POSTS INTEGRATED INTO BOLLARDS

-ROUND TOP TO MATCH

-6" DIA. GALV. STEEL PIPE, PRIMED

GRADE

& FILLED W/ 3,000 PSI CONC.,

-STEEL PIPE SHALL BE SET PLUMB

-18" SONOTUBE OR EQUIVALENT

BRACING WRAPPED IN TWO (2)

LAYERS OF 6 MIL POLY SET IN

AUGURED HOLE


& BACKFILLED W/ 4000 PSI CONC.

-PITCHED AWAY FROM PIPE

& MORTAR WASH FINISH

PVC COVER PROFILE

PAINTED YELLOW

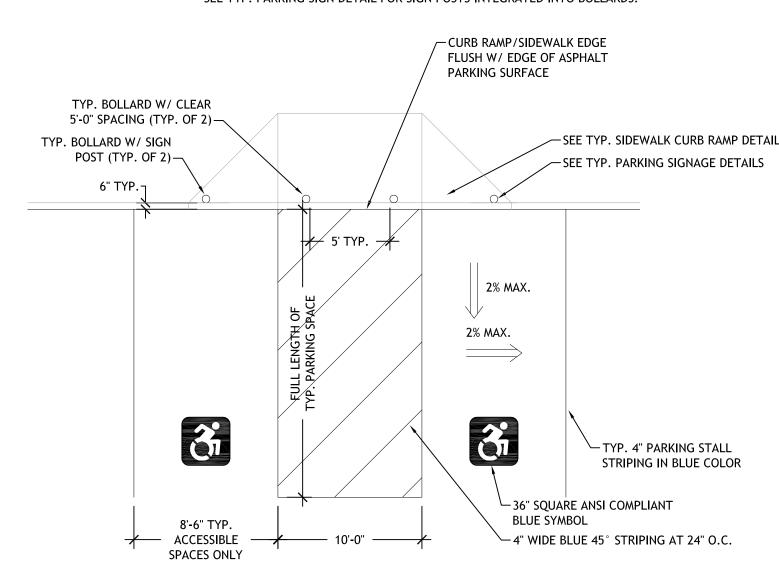


TYP. ACCESSIBLE PARKING SPACE DETAIL

NOTES: 1. MAXIMUM GRADE IN ACCESSIBLE PARKING SPACES AND ACCESS AISLE SHALL BE 2% IN ANY

- 2. PARKING SPACES SHALL BE LAID OUT & STRIPED WITH SIGNAGE IN CONFORMANCE WITH ANSI A117.1-2003 CHAPTER 502.
- 3. STALL STRIPING, HC SYMBOL, & ACCESS AISLE STRIPING TO BE SHERWIN WILLIAMS PROMAR TRAFFIC MARKING PAINT.
- ACCESSIBLE PARKING STALL, ACCESS AISLE, & SYMBOL COLOR: H.C. BLUE
- STOP BAR, TURN ARROWS, & CENTERLINE AT CURBCUT COLOR: WHITE ALL OTHER STRIPING - COLOR: YELLOW TM5495

2

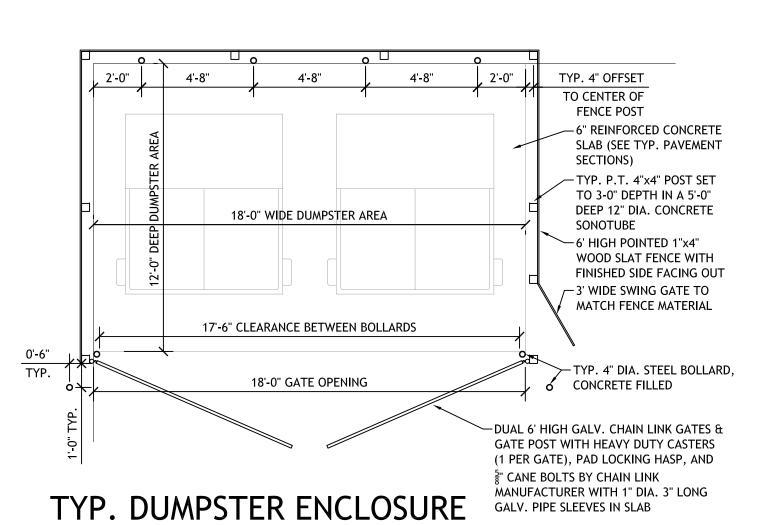

1. ENTRANCE SIDEWALK SLAB AT DOORWAY SHALL HAVE A GRADE AWAY FROM BUILDING NOT EXCEEDING 2% FOR A MINIMUM DISTANCE OF 5 FT.

4

2. ENTRANCE SIDEWALK SLAB EXTENSION BEYOND HINGE & LATCH SIDES OF DOOR SHALL MEET REQUIREMENTS OF ANSI A117.1-2003, CHAPTER 404.

LIGHT & POLE ASSEMBLY PER LIGHTING SCHEDULE - HANDHOLE W/ COVER - MAX 10H:1V TAPERED SLOPE TO BASE METAL FLASHING COLLAR $\frac{3}{4}$ " DIA. SCH. 40 PVC CONDUIT W/ BE STRIPED @ 45° IN YELLOW MAX 12H:1V RAMP TO BE #6 BARE CU GROUND CONNECTED - STL BASE PLATE & ANCHOR BOLTS PER MNFR. WITH 4" STRIPES @ 24" O.C. PAINTED YELLOW WITH TO POLE GROUNDING LUG & LONGITUDINAL GROOVING GROUND ROD W/ CLAMP - CHAMFER (1/8" TINES SPACED 3/4" O.C.)-WET CONC. & RUB DOWN RAISED AREAS AFTER FORM REMOVAL FOR SMOOTH RUBBED FINISH TAPER CURB TO MATCH SIDEWALK SLOPE TYP. OF (4) #5 VERT. BARS W/ #3 STIRRUPS @ 12" O.C. PAVING 2'-0" DIA. CONCRETE LIGHT POLE BASE. PROVIDE 4000 PSI CONCRETE WITH 5% AIR ENTRAINMENT. CHAMFER THE TOP TO MEET THE BASE COVER -PAVEMENT & CURB EDGE TO BE FLUSH (MAX. ALLOWABLE CHANGE IN HEIGHT 1/4") SCH. 40 PVC CONDUIT, PER N.E.C., MIN. 1" DIA.


TYP. SIDEWALK CURB RAMP DETAIL

NOTES: SEE TYP. HANDICAP ACCESSIBLE PARKING SPACE DETAIL FOR BOLLARD/SIGN PLACEMENT



LIGHTING CONDUCTORS TO BE FED FROM LIGHTING


CONTROL / ELEC. PANEL AT MIN. 24" BURY

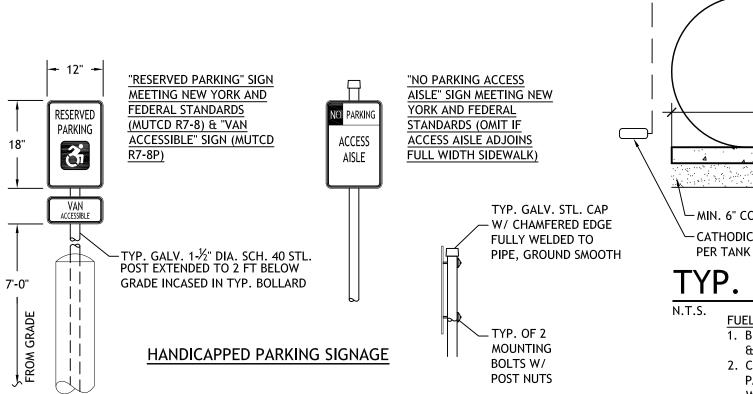

TYP. PARKING SIGNAGE DETAILS

5" x 8' COPPER CLAD GROUND

ROD. TIE GROUND ROD TO LIGHT POLE WITH #6 BARE COPPER

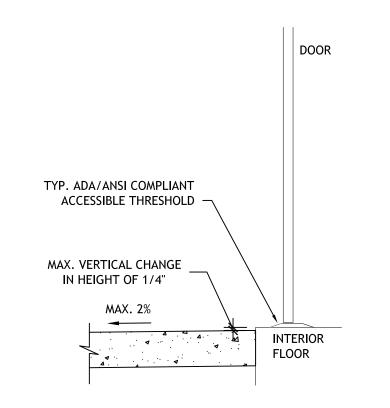

TYP. ACCESSIBLE ENTRANCE DETAIL


-RISER TO EXTEND 3" ABOVE GRADE OPERATIONAL PROPANE SUPPLY TO BUILDING EQUIPMENT - TOP OF GRADE TYP. 5" BELOW -DR-11 HDPE OR TYPE K CU GAS PIPING TO BLDG., BURIED MIN. 18' & SIZED PER FUEL COMPANY (1) 1000 GAL. LIQUID PROPANE TANK APPROVED FOR BURIED APPLICATIONS, ANCHORED TO CONC. SLAB 16'-0"± TYP. - 4" CONC. PAD W/ 6X6 W1.4xW1.4 W.W.M. & ANCHORS MIN. OR PER TANK MANUFACTURER'S RECOMMENDATIONS IF MORE SIGNIFICANT (EXTEND PAD 24" ± BEYOND SIDES OF TANKS FOR ANCHOR CONNECTION & - MIN. 6" COMPACTED SAND LAYER PROVIDE 4 EYE BOLTS PER — CATHODIC PROTECTION SYSTEM TANK, V.I.F.) PER TANK MANUFACTURER

TYP. BURIED LP TANK

- **FUEL TANK NOTES:**
- 1. BURIED TANK SHALL BE SUPPLIED & INSTALLED PER NFPA 58 STANDARDS & NYS FIRE CODE REQUIREMENTS.
- 2. CONTRACTOR TO PERFORM ALL EXCAVATION & INSTALLATION OF CONC. PAD, TRENCHING & PLACE ALL BACKFILL MATERIALS IN ACCORDANCE WITH FUEL TANK PROVIDER'S REQUIREMENTS. ADAPT TO REGULATOR
- WITH METER & EXTEND INTO BUILDING PER DWG. MECH. DWG'S 3. OWNER'S FUEL PROVIDER TO FURNISH & INSTALL TANKS INCLUDING
- CATHODIC PROTECTION, PIPING TO BUILDING, AND REGULATOR(S). 4. TANK SHALL BE INSTALLED WITH SELECT BACKFILL MATERIAL AND 6'
- TOPSOIL AT GRADE. 5. RISER COVER SHALL BE MIN 12" DIAMETER WITH GROUND SLOPING
- AWAY FROM RISER. ALL EXPOSED METAL SURFACES SHALL BE SHOP
- PRIMED & PAINTED. 6. UNDERGROUND GAS PIPING SHALL BE AT TYPICAL 18" DEPTH OF BURY.
- 7. SEE MECHANICAL DRAWINGS FOR GAS REGULATOR MOUNTING LOCATION
- AT BUILDING EXTERIOR.

REQUIRED SEPARATION DISTANCES FOR ABOVE GRADE TANKS.

8. SINGLE BELOW GRADE 1,000 GAL. TANK SIZED FOR 500 MBH FUEL DEMAND. SHOULD DESIGN LOAD VARY CONSULT WITH ENGINEER AND FUEL SUPPLIER. IF ABOVE GRADE TANKS ARE NECESSARY, TWO (2) 1,000 GAL. TANKS ARE RECOMMENDED, CONSULT WITH NFPA 58 FOR

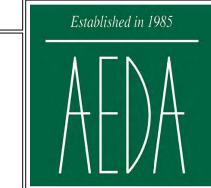

Architectural & Engineering DESIGN Associates, P.C.

1246 Rt. 3 P.O. Box 762 Plattsburgh, New York 12901 tel: 518.562.1800 fax: 518.562.1702 email: aedapc@aedapc.com

UNAUTHORIZED ALTERATIONS AND/OR ADDITIONS TO THIS DRAWING BEARING A LICENSED ARCHITECT'S OR ENGINEER'S SEAL IS A VIOLATION OF SECTION 7209. SUBDIVISION 2, OF THE NEW YORK STATE

ONLY COPIES FROM THE ORIGINAL OF THIS DRAWING BEARING THE ORIGINAL ARCHITECT'S OR ENGINEER'S SEAL AND SIGNATURE SHALL BE CONSIDERED VALID

O HAR O. Ш 0 SEVIL DOLL TAX F

DESIGN DEVELOPMENT PHASE SERVICES 100%

NOT FOR Architectural & Engineering DESIGN Associates PC CONSTRUCTION


REVISIONS


BY DATE

SITE DETAILS

PROJECT NO. 19029-002 DATE 11-08-19 DRAWN BY CHECKED BY

C502

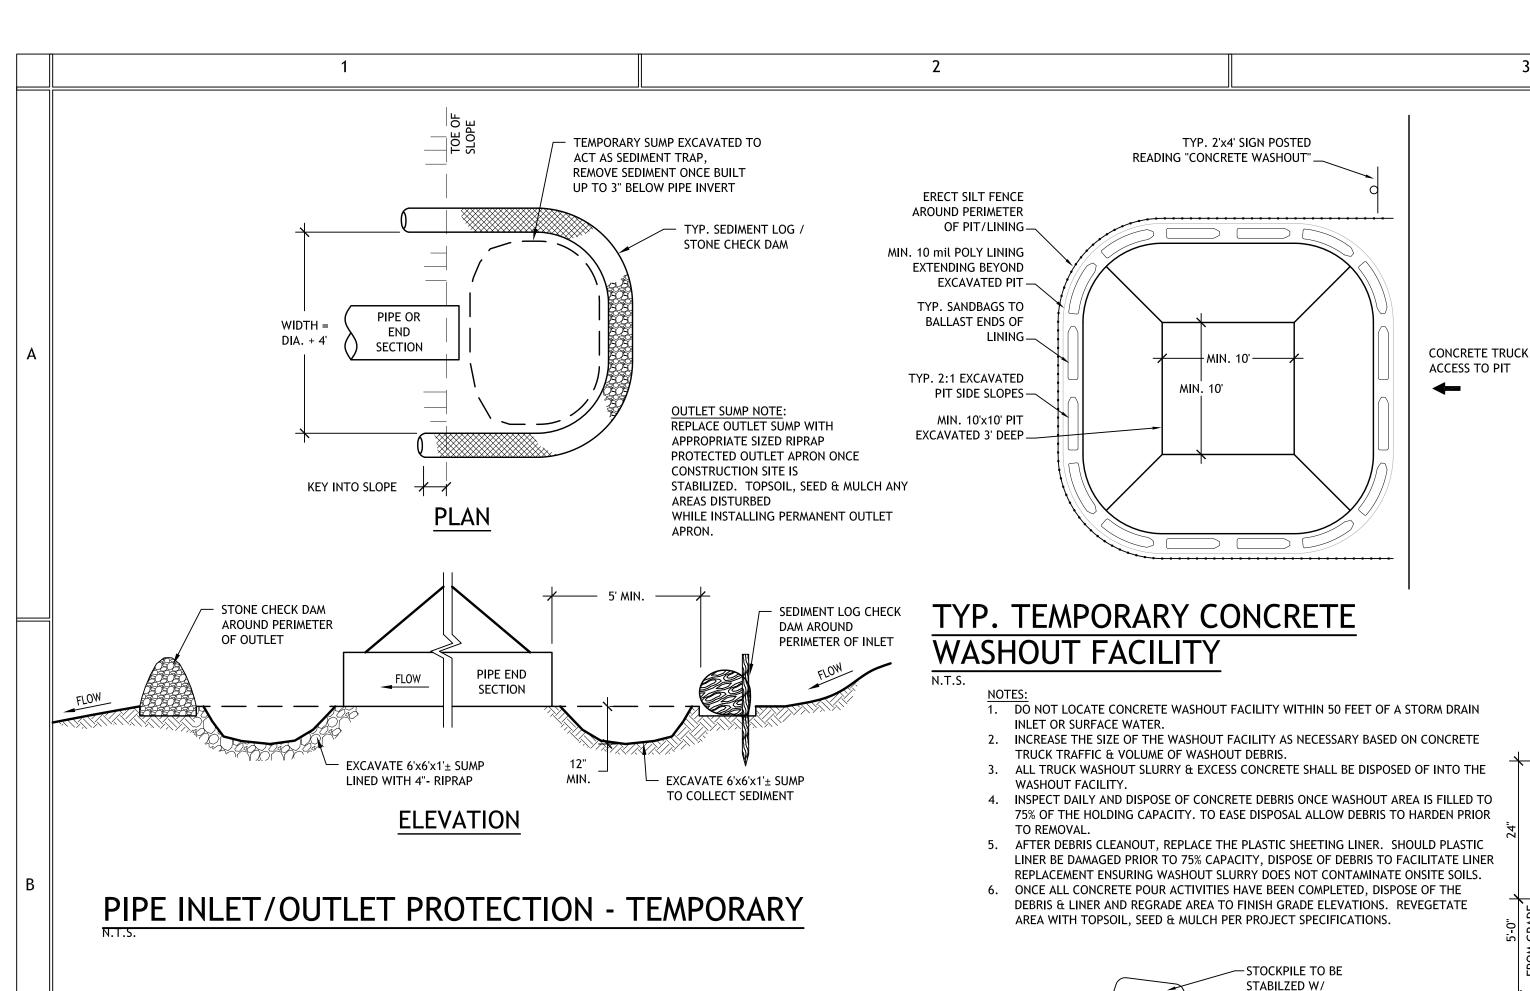

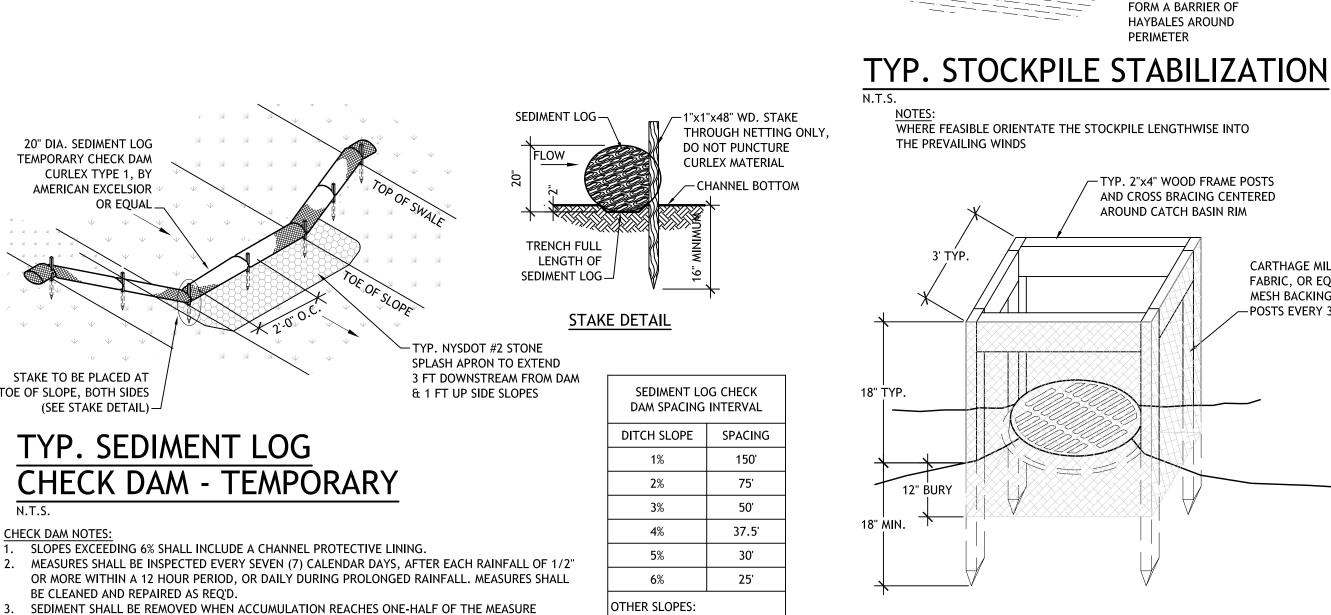

			PROTECTION DETAIL (GRASS
	SOIL RESTORATION REQUIREMEN	N.T.S.	
TYPE OF SOIL DISTURBANCE	SOIL RESTORATION REQUIREMENT	COMMENTS / EXAMPLES	
NO SOIL DISTURBANCE	RESTORATION NOT PERMITTED	PRESERVATION OF NATURAL RESOURCES	
MINIMAL SOIL DISTURBANCE	RESTORATION NOT REQUIRED	CLEARING AND GRUBBING	SOIL RESTORATION REQUIREMENTS
AREAS WHERE TOPSOIL IS STRIPPED ONLY - NO CHANGE IN GRADE	HSG A&B-APPLY 6" OF TOPSOIL / HSG C&D-AERATE & APPLY 6" OF TOPSOIL	PROTECT AREA FROM ANY ONGOING CONSTRUCTION ACTIVITY	DURING PERIODS OF RELATIVELY LOW TO MODERATE SOIL MOISTURE, THE DISTURBED SUBSOILS ARE RETURNED TO ROUGH GRADE AND THE FOLLOWING SOIL RESTORATION STEPS APPLIED:
AREAS OF CUT OR FILL	HSG A&B-AERATE & APPLY 6" OF TOPSOIL / HSG C&D-APPLY FULL SOIL RESTORATION		 APPLY 3 INCHES OF COMPOST OVER SUBSOIL TILL COMPOST INTO SUBSOIL TO A DEPTH OF AT LEAST 12 INCHES USING A
HEAVY TRAFFIC AREAS ON SITE (ESPECIALLY IN AN ZONE 5-25 FT AROUND BUILDINGS BUT NOT WITHIN A 5 FT PERIMETER AROUND FOUNDATION WALLS)	APPLY FULL RESTORATION (DE-COMPACTION AND COMPOST ENHANCEMENT)		CAT-MOUNTED RIPPER, TRACTOR MOUNTED DISC, OR TILLER, MIXING, AND CIRCULATING AIR AND COMPOST INTO SUBSOILS 3. ROCK-PICK UNTIL UPLIFTED STONE/ROCK MATERIALS OF 4 INCHES AND LARGER SIZE ARE CLEARED OFF THE SITE 4. APPLY TOPSOIL TO A DEPTH OF 6 INCHES 5. VEGETATE AS REQUIRED BY SEEDING SPECIFICATIONS
AREAS WHERE RUNOFF REDUCTION AND/OR INFILTRATION PRACTICES ARE APPLIED	RESTORATION NOT REQUIRED, BUT MAY BE APPLIED TO ENHANCE THE REDUCTION SPECIFIED FOR APPROPRIATE PRACTICES	KEEP CONSTRUCTION EQUIPMENT FROM CROSSING THESE AREAS. TO PROTECT NEWLY INSTALLED PRACTICE FROM ANY ONGOING CONSTRUCTION ACTIVITIES CONSTRUCT A SINGLE PHASE OPERATION FENCE AREA	
REDEVELOPMENT PROJECTS	SOIL RESTORATION IS REQUIRED ON REDEVELOPMENT PROJECTS IN AREAS WHERE EXISTING IMPERVIOUS AREA WILL BE CONVERTED TO PERVIOUS AREA		AERATION: INCLUDES THE USE OF MACHINES SUCH AS TRACTOR DRAWN IMPLEMENTS WITH COULTERS MAKING A NARROW SLIT IN THE SOIL, A ROLLER WITH MANY SPIKES MAKING INDENTATIONS IN THE SOIL, OR PRONGS WHICH FUNCTION LIKE A MINI-SUBSOILER.

20" DIA. SEDIMENT LOG

TEMPORARY CHECK DAM

CURLEX TYPE 1, BY

AMERICAN EXCELSIOR

STAKE TO BE PLACED AT

(SEE STAKE DETAIL) -

TYP. SEDIMENT LOG

BE CLEANED AND REPAIRED AS REQ'D.

CHECK DAM - TEMPORARY

SLOPES EXCEEDING 6% SHALL INCLUDE A CHANNEL PROTECTIVE LINING

HEIGHT. SEDIMENT SHALL BE DISPOSED OF AS UNSUITABLE MATERIAL.

TOE OF SLOPE, BOTH SIDES

CHECK DAM NOTES:

OTHER SLOPES: SPACING = 1.5'/SLOPE(%) TYP. CATCH BASIN INLET PROTECTION DETAIL (GRASS AREAS)

> JBSOILS ARE RETURNED TO ROUGH GRADE AND THE FOLLOWING SOIL RESTORATION TEPS APPLIED: APPLY 3 INCHES OF COMPOST OVER SUBSOIL TILL COMPOST INTO SUBSOIL TO A DEPTH OF AT LEAST 12 INCHES USING A CAT-MOUNTED RIPPER, TRACTOR MOUNTED DISC, OR TILLER, MIXING, AND CIRCULATING AIR AND COMPOST INTO SUBSOILS ROCK-PICK UNTIL UPLIFTED STONE/ROCK MATERIALS OF 4 INCHES AND LARGER SIZE ARE CLEARED OFF THE SITE APPLY TOPSOIL TO A DEPTH OF 6 INCHES **VEGETATE AS REQUIRED BY SEEDING SPECIFICATIONS** DMPOST SPECIFICATIONS: COMPOST SHALL BE AGED, FROM PLANT DERIVED ATERIALS, FREE OF VIABLE WEED SEEDS, HAVE NO VISIBLE FREE WATER OR DUST

TEMPORARY GRASS COVER, GEOTEXTILE

OR PLASTIC COVERS

WHERE FEASIBLE ORIENTATE THE STOCKPILE LENGTHWISE INTO

THE PREVAILING WINDS

12" BURY

REMAIN OVER WINTER

FORM A BARRIER OF HAYBALES AROUND

TYP. 2"x4" WOOD FRAME POSTS

AROUND CATCH BASIN RIM

AND CROSS BRACING CENTERED

CARTHAGE MILLS FX-11 FILTER

FABRIC, OR EQUAL WITH WIRE

MESH BACKING STAPLED TO

-POSTS EVERY 3 INCHES

ERATION: INCLUDES THE USE OF MACHINES SUCH AS TRACTOR DRAWN IMPLEMENTS ITH COULTERS MAKING A NARROW SLIT IN THE SOIL, A ROLLER WITH MANY SPIKES AKING INDENTATIONS IN THE SOIL, OR PRONGS WHICH FUNCTION LIKE A MINI-SUBSOILER.

TYP. GRASS COVER ALL DISTURBED AREAS, SEE NOTES FOR STABILIZATION- SEE STORAGE NOTES TYP. 4H:1V SIDE SLOPE TO BASIN FLOOR — BOTTOM WIDTH VARIES (0 FT TO 5 FT) MIN. 3' SEPARATION TO GROUNDWATER -BOTTOM OF BASIN ELEV. = 346.00TYP. OF ONE OBSERVATION WELL IN BASIN BOTTOM INFILTRATION BASIN CROSS SECTION PEAK STORAGE ELEVATIONS-WQv PEAK HEIGHT = 347.08 1-YR PEAK HEIGHT = 348.07 1. BASIN SIDE SLOPES TO BE GRADED AS SHOWN AND STABILIZED WITH 6 INCH LAYER OF TOPSOIL WITH 10-YR PEAK HEIGHT = 349.13 GRASS SEED & STABILIZATION FABRIC EQUAL TO AMERICAN EXCELSIOR CURLEX III. 25-YR PEAK HEIGHT = 349.39 2. SEE RIPRAP OUTLET PROTECTION DETAIL FOR ADDITIONAL INFORMATION ON OUTFALL PROTECTION. 100-YR PEAK HEIGHT = 349.57 . SEE SITE PLAN FOR EMERGENCY SPILLWAY LOCATION, SLOPE -PANELLA TYPE CLEANOUT WITH SPILLWAY OUTFALL TO DRAIN COUNTERSUNK HEAD, SIZED PER 6" DIA. PVC PIPE, TOP OF CLEANOUT FLUSH WITH FINISH GRADE PRACTICE DESCRIPTION NYSDEC PERMIT MUST BE MĀĪNTAINI IN ACCORDANCE WI -HAND TAMP MATERIAL AROUND O&M PLAN PIPE TO SECURE PLUMB O NOT REMOVE OR ALTER -6" DIA. PERFORATED SCH.40 PVC – TYP. RIB-BAK U-CHANNEL VERT. RISER PIPE SIGN POST WITH HEX HEAD - ANCHOR BOTTOM OF PIPE IN BOLTS, NUTS & WASHERS HALF BAG OF QUICKCRETE FOR SIGN ATTACHMENT, BURIED TO DEPTH OF 4'-0"

TYP. OF (1) PER INFILTRATION PRACTICE

TYP. OBSERVATION WELL


TYP. STORMWATER SIGNAGE DETAILS

ONE BMP SIGN TO BE INSTALLED AT EACH OF THE FOLLOWING PRACTICES WITH THE DESCRIPTIONS AS NOTED. COORDINATE PERMIT # AND LOCATION WITH ENGINEER PRIOR TO ORDERING SIGNS.

INFILTRATION BASI

STONE EDGE TREATMENT IF ADJOINING PAVED SURFACE COMPACTED TOPSOIL -MANUFACTURER APPROVED -ANCHOR TRENCH SLOPE PROTECTION -MATTING EQUAL TO AMERICAN EXCELSIOR CURLEX III INSTALL SLOPE PROTECTION MATTING ON ALL SLOPES 3 ON 1 OR GREATER. INSTALLATION METHOD SHALL BE PER MANUFACTURERS RECOMMENDATIONS. COORDINATE MATTING INSTALLATION WITH TOPSOIL PLACEMENT & SEEDING TO ENSURE MINIMAL SOIL & SEED

TYP. EROSION CONTROL BLANKET

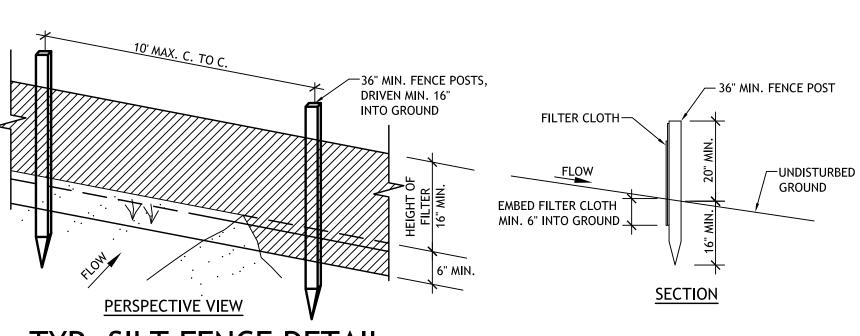

TYP. SILT FENCE DETAIL

1. PREFABRICATED SILT FENCE EOUAL TO MIRAFI SILT FENCE W/ MIRAFI 100X WOVEN FABRIC & 1-1/4" SO. HARDWOOD POSTS. 2. FILTER CLOTH TO BE FASTENED SECURELY TO WOODEN STAKES WITH STAPLES, OR OTHER COMPARABLE FASTENERS. 3. WHEN TWO SECTIONS OF FILTER CLOTH ADJOIN EACH OTHER THEY SHALL BE OVERLAPPED BY SIX INCHES AND FOLDED. 4. MAINTENANCE SHALL BE PERFORMED AS NEEDED AND MATERIAL REMOVED WHEN "BULGES" DEVELOP IN THE SILT FENCE.

Architectural & Engineering

DESIGN Associates, P.C.

1246 Rt. 3 P.O. Box 762 Plattsburgh, New York 12901 tel: 518.562.1800 fax: 518.562.1702 email: aedapc@aedapc.com UNAUTHORIZED ALTERATIONS AND/OR

SEAL IS A VIOLATION OF SECTION 7209. SUBDIVISION 2, OF THE NEW YORK STATE

ADDITIONS TO THIS DRAWING BEARING A

LICENSED ARCHITECT'S OR ENGINEER'S

ARCHITECT'S OR ENGINEER'S SEAL AND SIGNATURE SHALL BE CONSIDERED VALID

ENI, LLC HARTFOF ELO DEVEL GENE

DESIGN

DEVELOPMENT PHASE **SERVICES 100%** NOT FOR

REVISIONS

SITE **DETAILS**

PROJECT NO. DRAWN BY **CHECKED BY**

C503

CONSTRUCTION ENTRANCE . STONE SIZE - USE 2" STONE, OR RECLAIMED OR RECYCLED CONCRETE EQUIVALENT. 2. LENGTH - NOT LESS THAN 50 FEET (EXCEPT ON A SINGLE RESIDENCE LOT WHERE A 30 SEVIL DOLL TAX I 3. WIDTH - TWENTY (20) FOOT MIN., BUT NOT LESS THAN THE FULL WIDTH AT POINTS WHERE INGRESS AND EGRESS OCCUR (EXCEPT ON A SINGLE RESIDENCE LOT WHERE A 12 FOOT

ROAD

TOP OF

BERM

TYP. 3H:1V RETURN SLOPE

BENCH AT ELEV. = 348.92

-6"x8" P.T. TIMBER LEVEL SPREADER

UNDER TIMBER & EXTEND LENGTH OF

MOUNTABLE

STABILIZATION TO EXTEND TO

UNDISTURBED GROUND MIN.

RIPRAP OUTLET PROTECTION

TOP ELEV. = 349.00. SPILLWAY

TO GRADE

LEVEL SPREADER SPILLWAY DETAIL

LAYER OF STONE -

TYP. STABILIZED

MINIMUM WIDTH WOULD APPLY).

BE REMOVED IMMEDIATELY.

-STONE APRON MIN.

SECTION

RIPRAP d50 LENGTH*

4" 6 FT+/-

6" 25 FT+/-

10 FT+/-

TYP. RIPRAP APRON DETAIL

PIPE DIA.

4"/6"

LVL SPREADER

INTO A STRUCTURE)

4. FILTER CLOTH - WILL BE PLACED OVER THE ENTIRE AREA PRIOR TO PLACING OF STONE

ENTRANCES SHALL BE PIPED ACROSS THE ENTRANCE. IF PIPING IS IMPRACTICAL, A

6. MAINTENANCE - THE ENTRANCE SHALL BE MAINTAINED IN A CONDITION WHICH WILL

PREVENT TRACKING OR FLOWING OF SEDIMENT ONTO PUBLIC RIGHTS-OF-WAY. ALL

SEDIMENT SPILLED, DROPPED, WASHED, OR TRACTED ONTO PUBLIC RIGHTS-OF-WAY MUST

7. WHEN WASHING IS REQUIRED, IT SHALL BE DONE ON AN AREA STABILIZED WITH STONE AND

- TYP. FLARED END

WIDTH

6 FT+/-

11 FT+/-

18 FT+/-

9 IN.

14 IN.

F.E.S. & R.G.

F.E.S.

RIPRAP APRON SCHEDULE

(*) LENGTHS & WIDTHS ARE MINIMUM REQUIRED, CONTRACTOR SHALL EXTEND TO

RODENT GUARD (R.G.) EQUAL TO METAL ANIMAL GUARD 1270DA BY HANCOR TO BE

INSTALLED AT FOOTING DRAIN & ROOF DRAIN OUTFALLS (OMIT WHEN DISCHARGE

BOTTOM OF SLOPE, EDGE OF DITCH, ETC. WHERE FIELD CONDITIONS REQUIRE

SECTION W/ RODENT GUARD (SEE NOTES)

8. PERIODIC INSPECTION AND NEEDED MAINTENANCE SHALL BE PROVIDED AFTER EACH RAIN.

MOUNTABLE BERM WITH 5:1 SLOPES WILL BE PERMITTED.

WHICH DRAINS INTO AN APPROVED SEDIMENT TRAPPING DEVICE.

5. SURFACE WATER - ALL SURFACE WATER FLOWING OR DIVERTED TOWARD CONSTRUCTION

TOP OF BERM VARIES,

TYP. ELEV. = 350.00 —

Architectural & Engineering D E S I G N Associates P C CONSTRUCTION

BY DATE

19029-002 11-08-19

SIGNAGE





- CEMENT BOARD SIDING AND TRIMS

3 EXTERIOR RENDERING 2
12" = 1'-0"





PROJECT NO. DRAWN BY CHECKED BY

A201

SEVILLE DEVELOPMENT, INC. DOLLAR GENERAL - HARTFORD TAX PARCEL 141.-1-36

Architectural &

Engineering

DESIGN

Associates, P.C.

1246 Rt. 3 P.O. Box 762 Plattsburgh, New York 12901 tel: 518.562.1800 fax: 518.562.1702 email: aedapc@aedapc.com

UNAUTHORIZED ALTERATIONS AND/OR ADDITIONS TO THIS DRAWING BEARING A LICENSED ARCHITECT'S OR ENGINEER'S SEAL IS A VIOLATION OF SECTION 7209, SUBDIVISION 2, OF THE NEW YORK STATE EDUCATION LAW.

ONLY COPIES FROM THE ORIGINAL OF THIS DRAWING BEARING THE ORIGINAL ARCHITECT'S OR ENGINEER'S SEAL AND SIGNATURE SHALL BE CONSIDERED VALID TRUE COPIES.

NOT FOR Architectural & Engineering
DESIGN Associates PC CONSTRUCTION

REVISIONS # BY DATE

FRONT ELEVATION AND RENDERING